
# HARBORSIDE STATIONARY PUMP IMPROVEMENTS

BID NO. 23-B-014

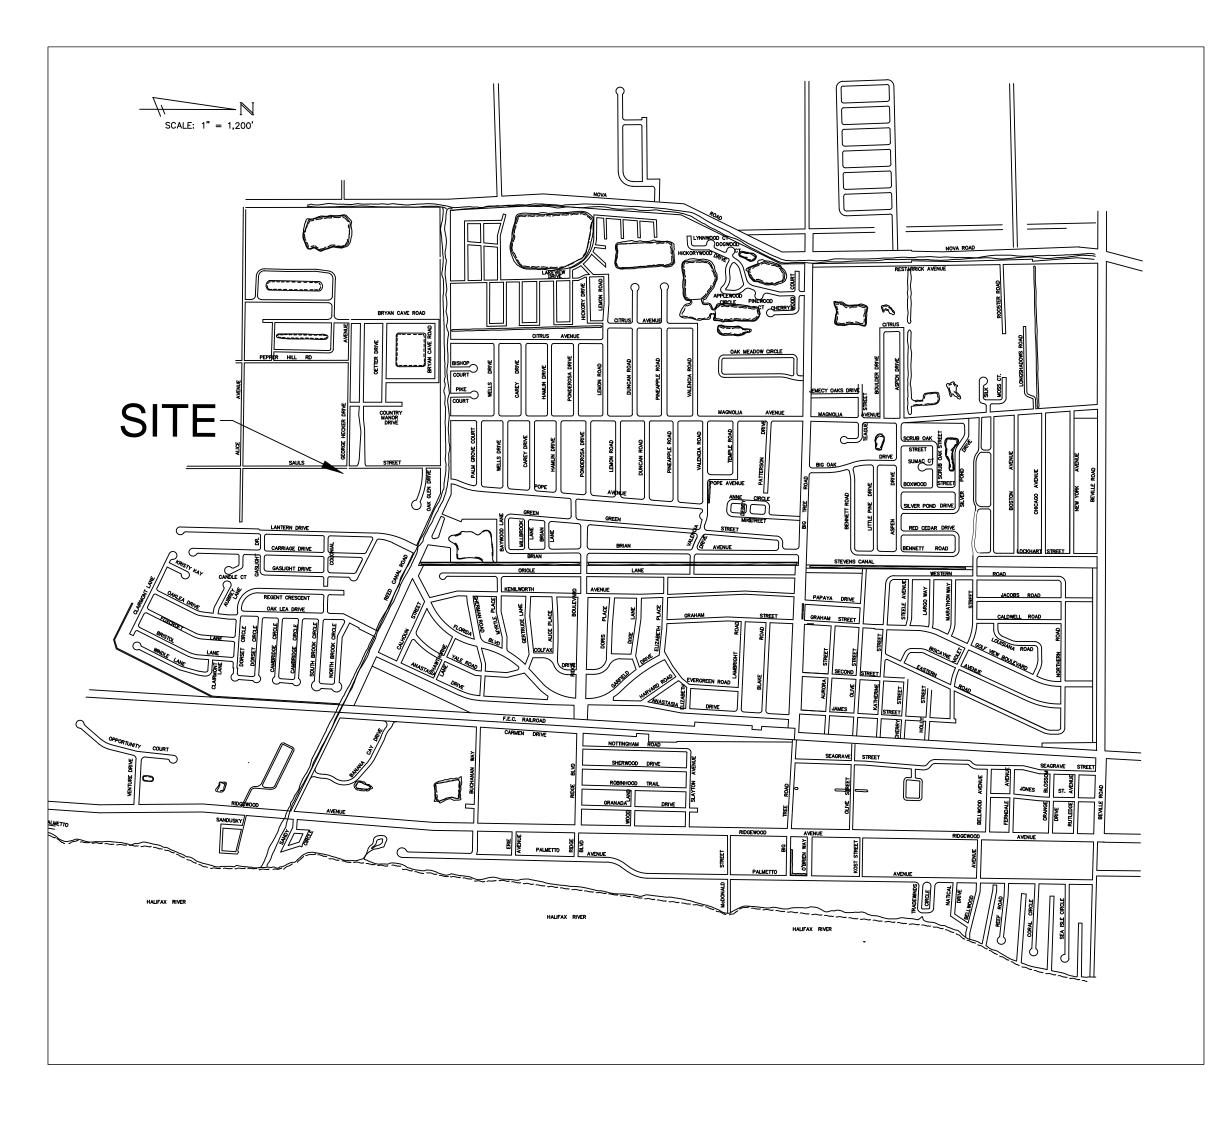



CITY OFFICIALS

MAYOR WILLIAM C. HALL

VICE MAYOR ERIC SANDER

COUNCIL MEMBERS LISA O'NEAL DOUG QUARTIER BRANDON YOUNG

CITY MANAGER

SHEET INDEX

PLANS MAY BE REDUCED SIZE
SCALE MAY NOT BE AS SHOWN


1 COVER SHEET2 DESIGN3 DETAILS

**EROSION CONTROL** 

SHT. TITLE

LOCATION MAP

CITY OF SOUTH DAYTONA
PUBLIC WORKS DEPARTMENT

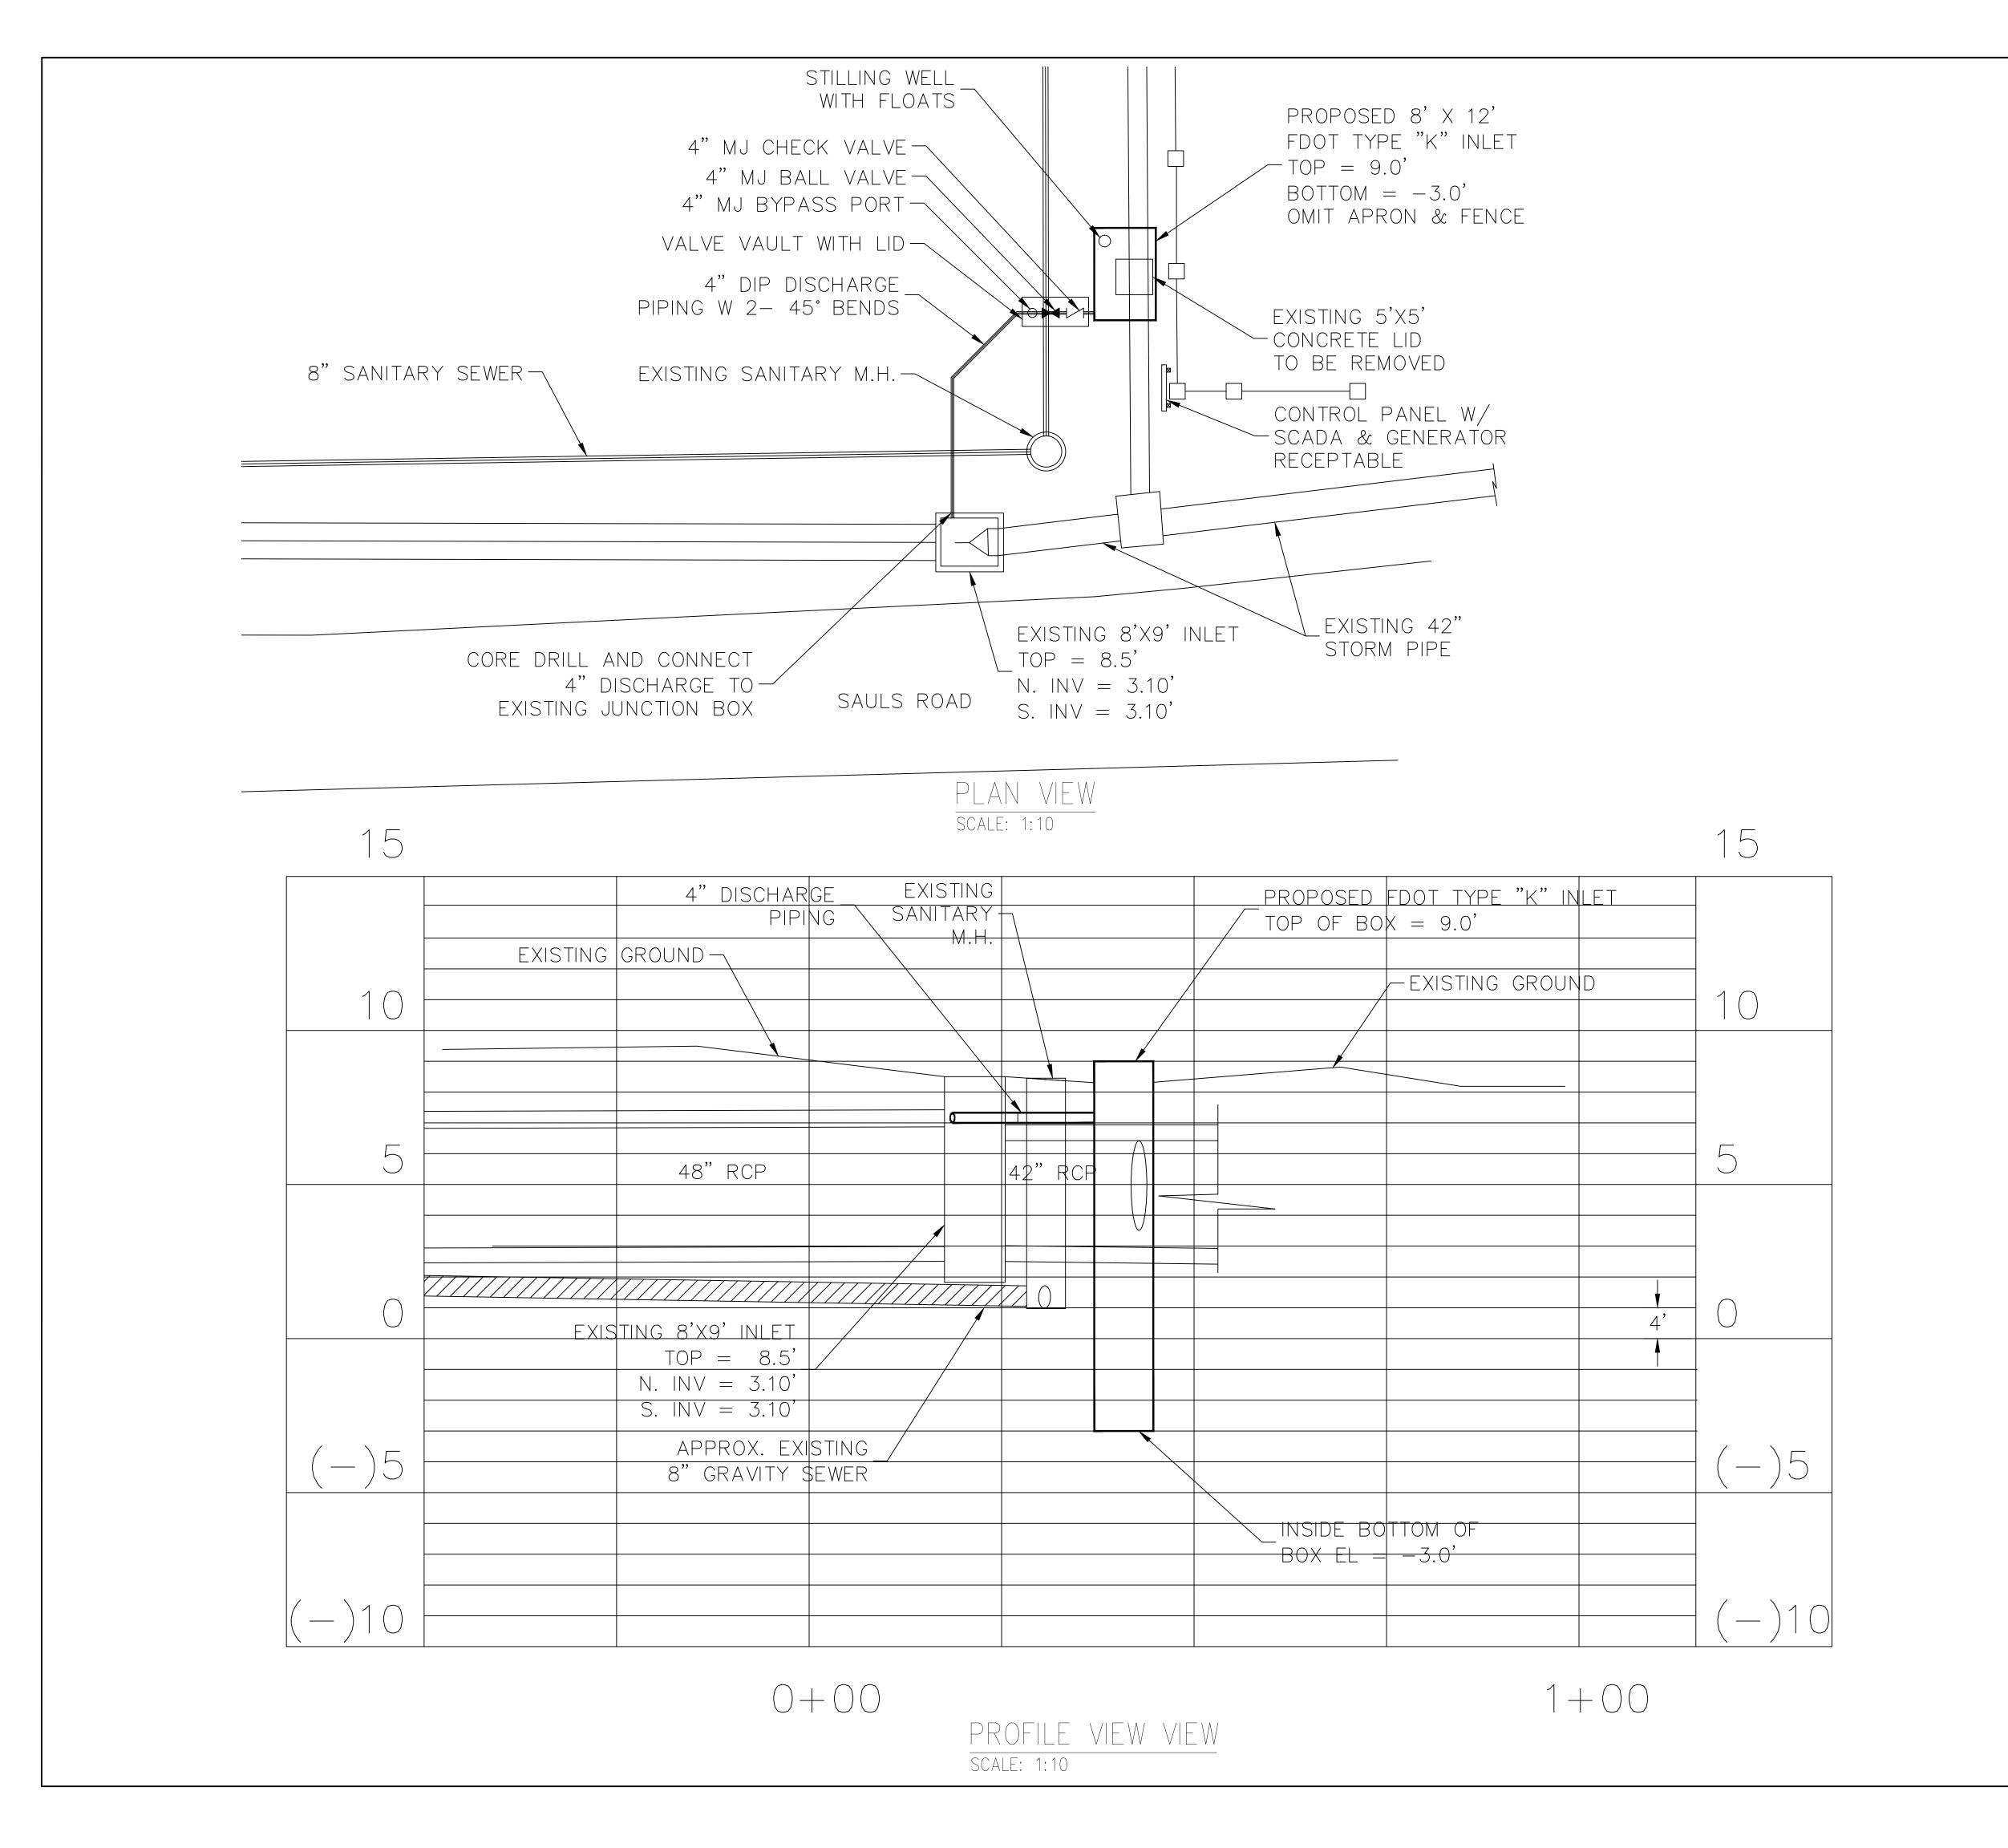


NOTE:


BEST MANAGEMENT PRACTICES SHALL BE UTILIZED DURING THE DEMOLITION AND CONSTRUCTION PHASE BY THE CONTRACTOR ON THIS PROJECT THE DELINEATED MEASURES ARE THE MINIMUM REQUIRED AND ADDITIONAL CONTROLS WILL BE UTILIZED AS NEEDED, DEPENDENT OPON ACTUAL SITE CONDITIONS AND CONSTRUCTION OPERATIONS.

48 HOURS BEFORE DIGGING
CALL 811
SUNSHINE STATE ONE CALL
OF FLORIDA

NO.	DATE	APPR.	R E V I S I O N	
DESIGNED: BNP			CITY OF SOUTH DAYTONA PUBLIC WORKS DEPARTMENT	Steve Danskine
DRAWN: BNP			1672 SOUTH RIDGEWOOD AVE, SOUTH DAYTONA, FLORIDA 32119 FAX: (386) 322-3029 PHONE: (386) 322-3080	
CHECKED:			HARBORSIDE STATIONARY PUMP IMPROVEMENT	NOT VALID WITHOUT
DATE: 5-18-23			SOUTH DAYTONA	NOT VALID WITHOUT EMBOSSED SEAL DWG:
PLOTTED:			IMPROVEMENT PROJECT	PROJECT NO.
			SOUTH DAYTONA FL	
SCALE: AS SHOWN		OWN	DATE	SHT. <b>2</b> OF <b>4</b>

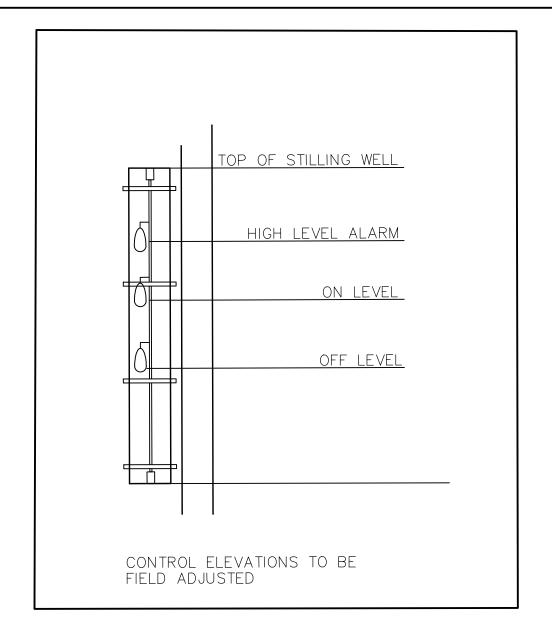

PUMP STATION FLOAT CONTROLS
NOT TO SCALE

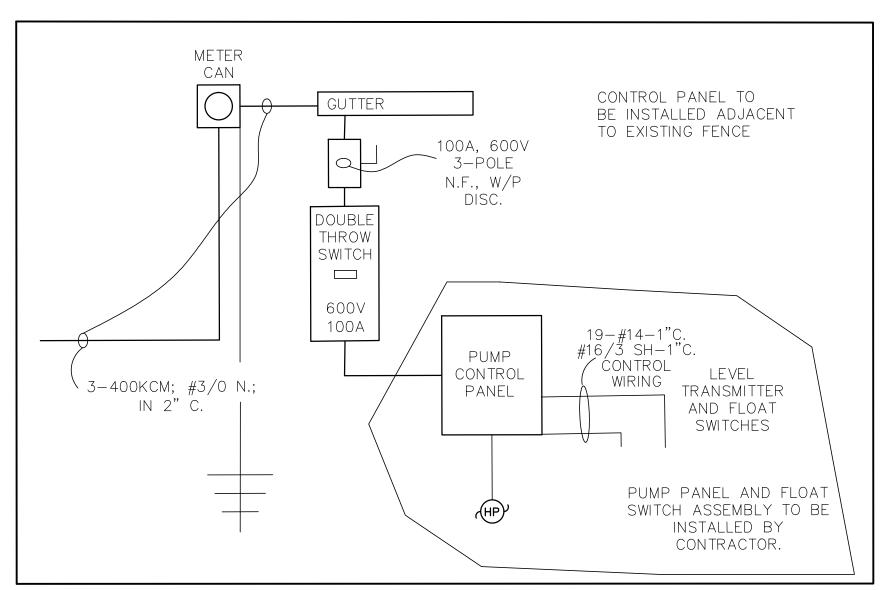

PUMPSTATION CONTROL PANELS
INCLUDE VFD & GENERATOR RECEPTABLE
NOT TO SCALE

# SERVICE RISER NOTES

1. CONTRACTOR TO COORDINATE WITH FPL SITE SERVICE REP THE PROVISION OF A PAD-MOUNT TRANSFORMER WITHIN THE REAL PROPERTY OF THE SITE PLAN. INSTALL FPL-FURNISHED 5" PRIMARY CONDUIT (OR DIRECTIONAL DRILL) AND TRANSFORMER PAD TO FPL SPECIFICATIONS AND REQUIREMENTS. OBTAIN ANY EASEMENTS OR RIGHTS-OF-WAY AND PAY ALL COSTS AND FEES ASSOCIATED THEREWITH. PROVIDE SERVICE LATERAL INDICATED.

2. PROVIDE FPL-APPROVED IN-LINE METER CAN IN LOCATION SHOWN IN PLANS SUITABLE FOR 100-AMP, 3-PHASE SERVICE AT 460 VOLTS.

3. PROVIDE 100 AMP, 3-POLE, 600 VOLT, ADJUSTABLE TRIP THERMAL-MAGNETIC CIRCUIT BREAKER WITH SHUNT TRIP IN NEMA 1 ENCLOSURE. LABEL THIS BREAKER AS "SERVICE MAIN DISCONNECT."


4. SERVICE GROUND TO BE #1/0 BARE COPPER WIRE, CONNECTED TO NEUTRAL AND GROUND LUGS OF SERVICE MAIN BREAKER ENCLOSURE, TO BUILDING FOOTER REINFORCING STEEL BAR, TO TWO EACH, 20-FOOT DRIVEN COPPER ELECTRODES, 20 FEET ON CENTERS, MINIMUM, AND IF PRESENT, TO METAL WATER PIPE.


5. LIGHTNING ARRESTOR TO BE SQUARE D, MODEL SDSA3650.


6. STORMWATER PUMP CONTROL PANEL (PCP) WITH ANALOG/DIGITAL INPUT/OUTPUT CAPABILITIES TO AUTOMATICALLY RUN PUMPS AND MAINTAIN WATER LEVEL AT ADJUSTABLE PRESET LEVEL. PCP SHALL INCLUDE INTEGRAL FLOAT WIRING.


NORMAL PUMP OPERATION (ON FLOATS):


REFER TO PUMP STATION FLOAT CONTROLS FOR ESTABLISHED LEVELS.

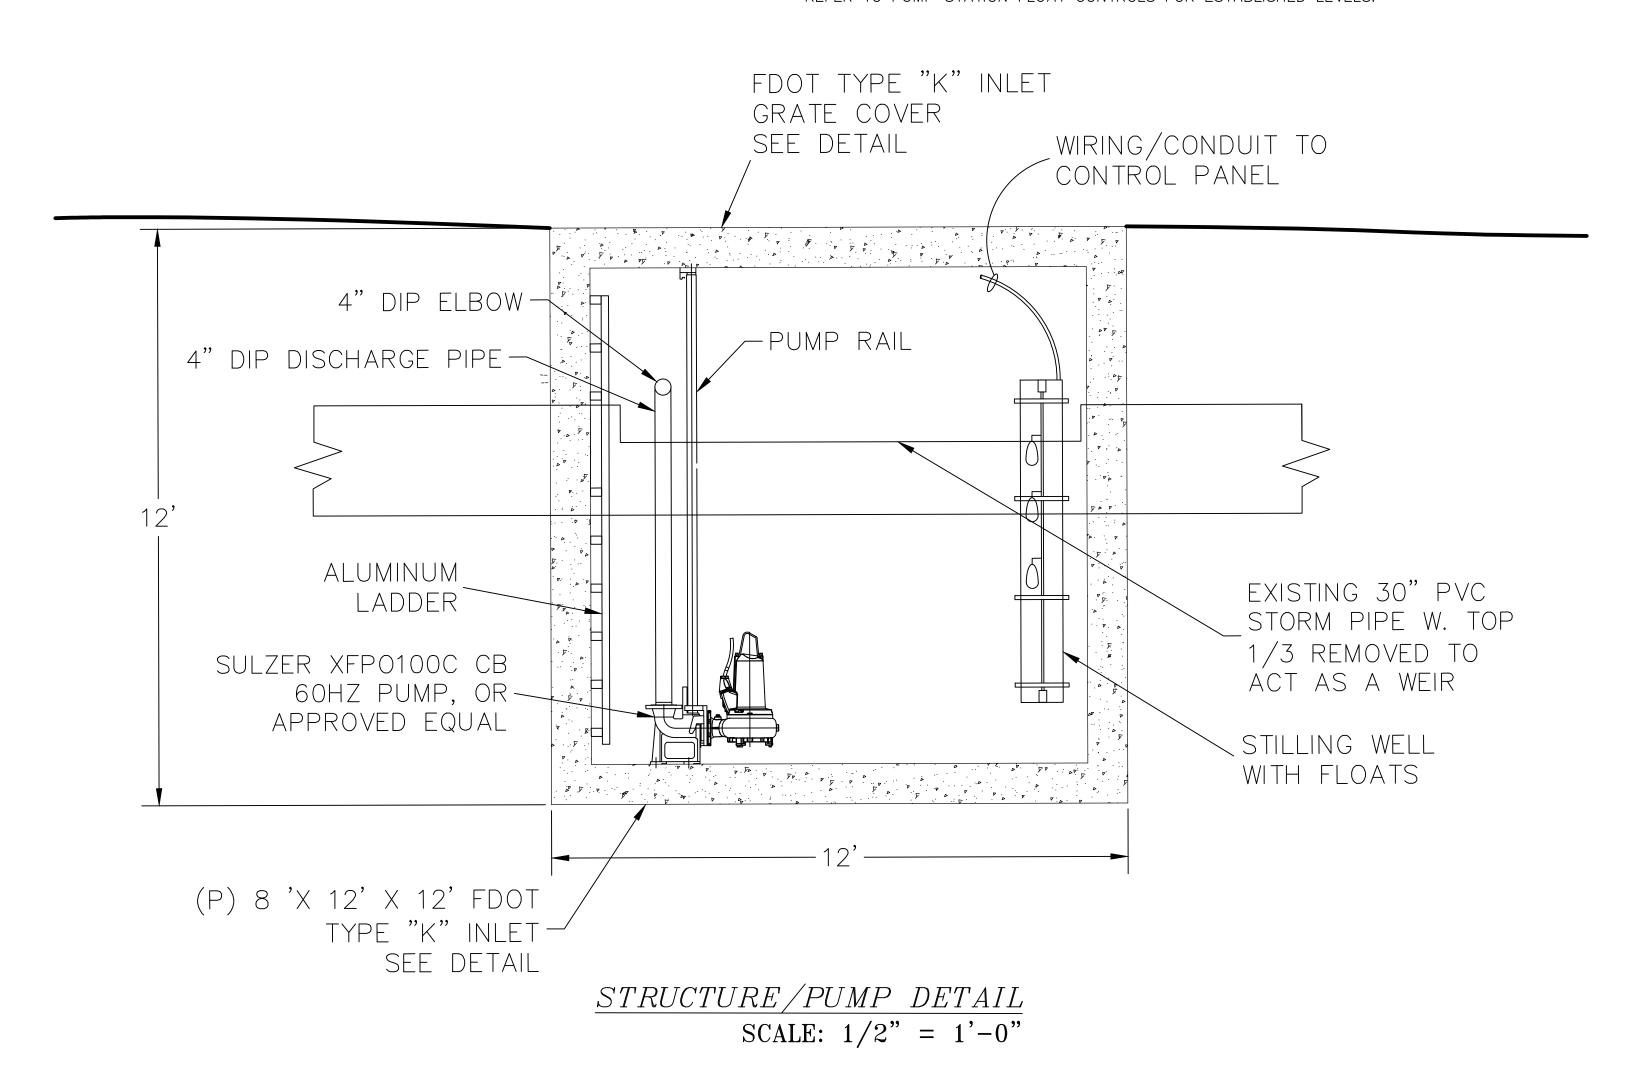

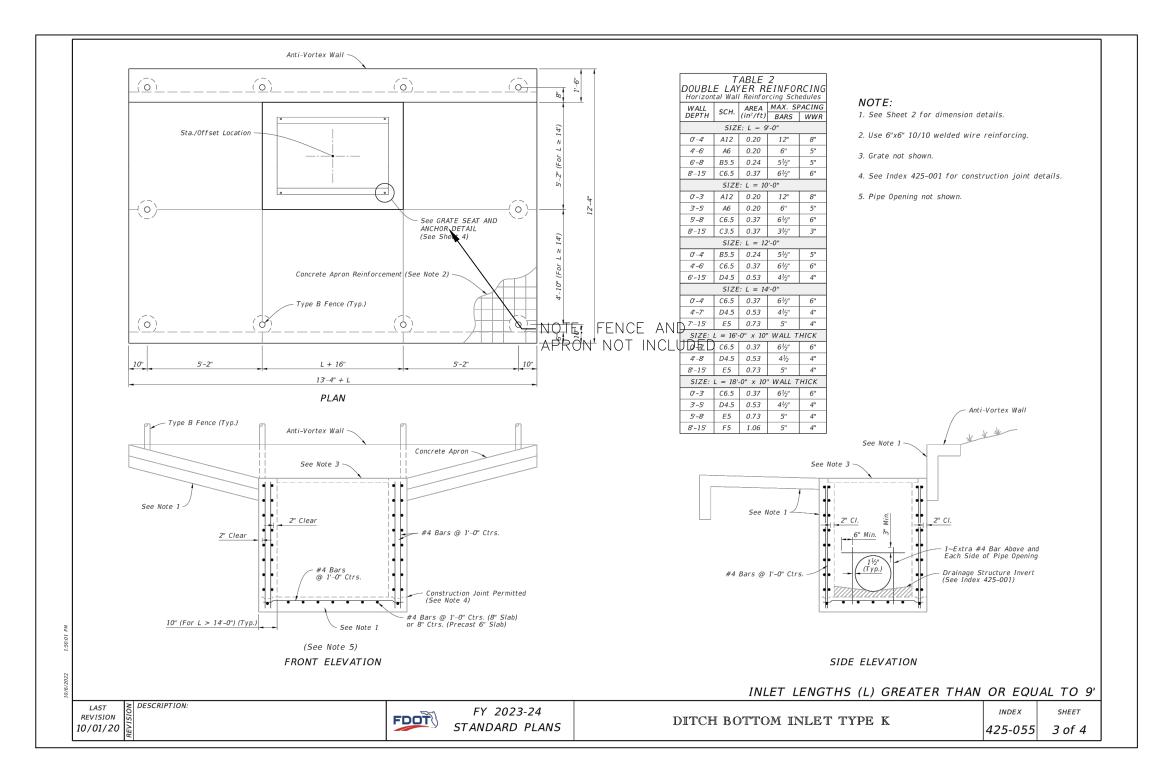

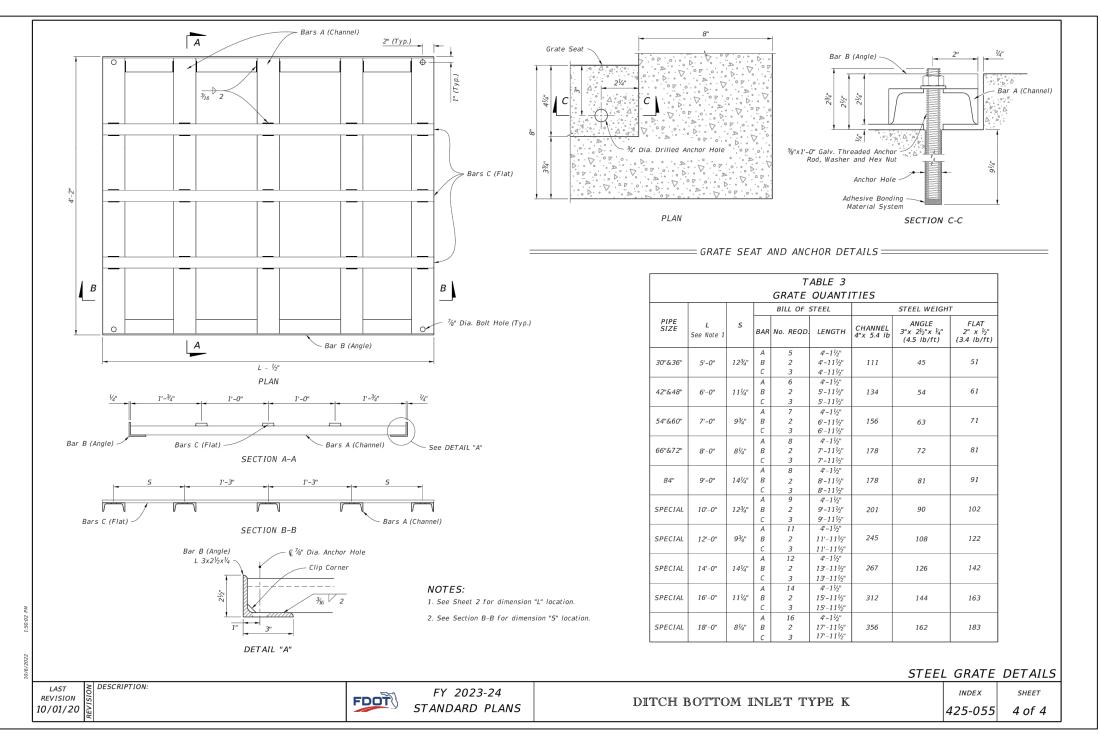


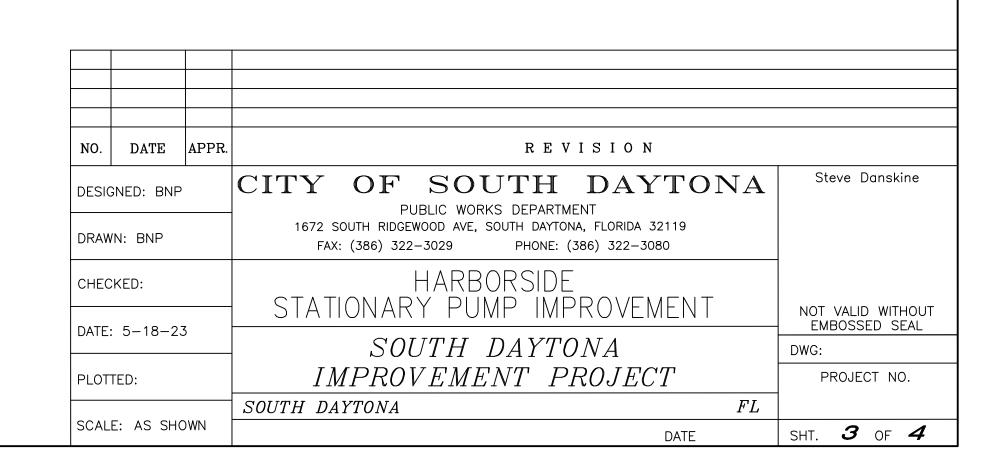

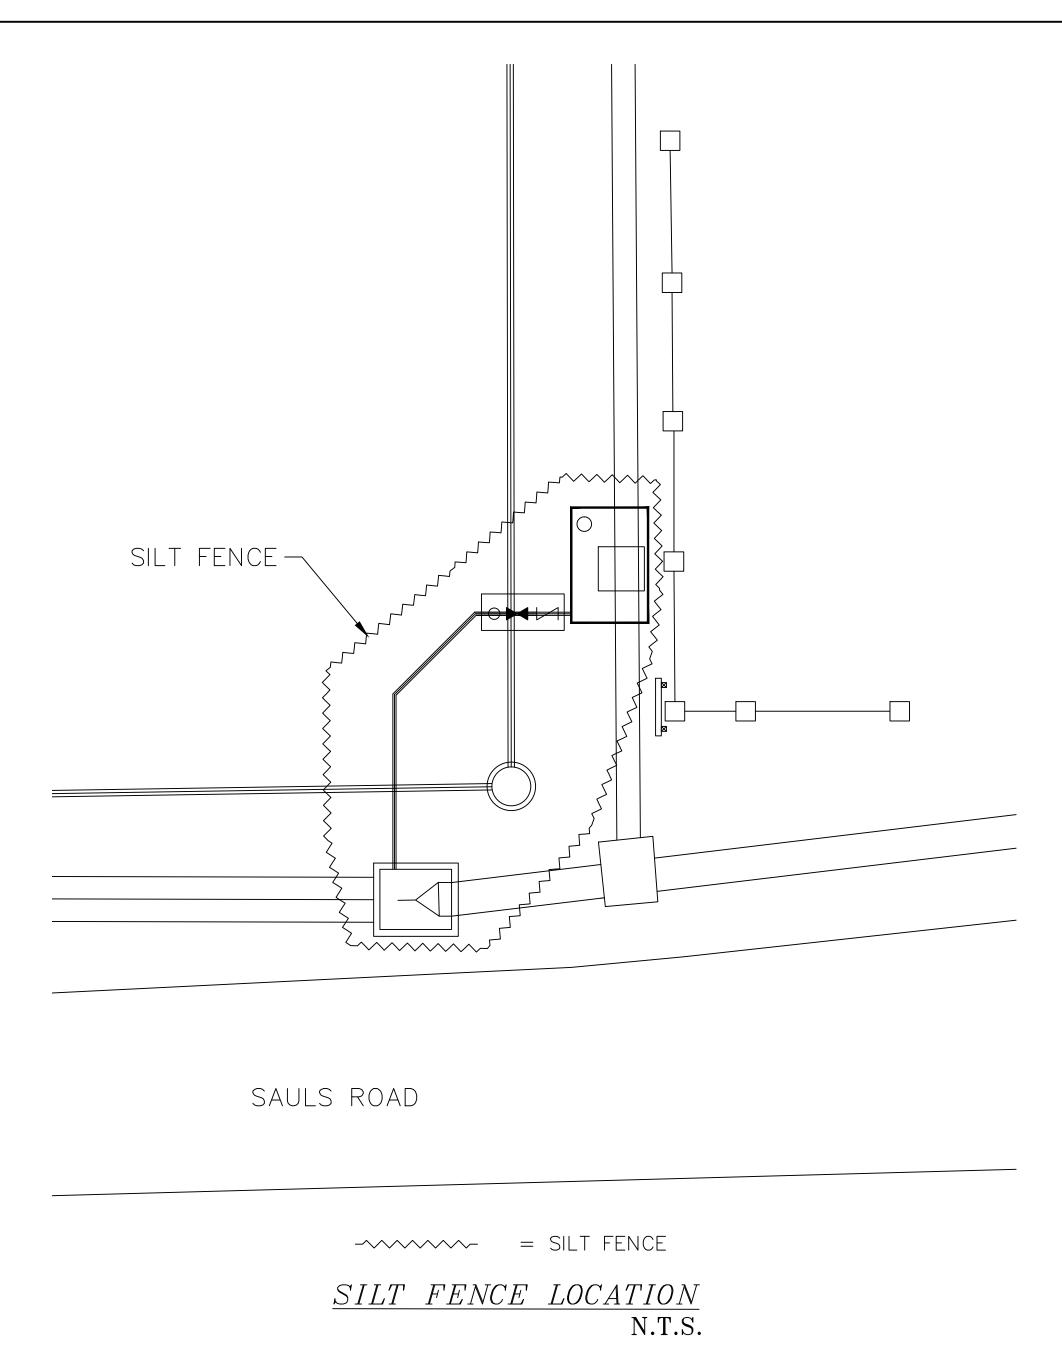


### **DEMOLITION NOTES:**

- 1. THE CONTRACTOR IS RESPONSIBLE TO MAINTAIN SAFE ACCESS FOR AUTHORIZED CITY AND UTILITY WORKERS AND VEHICLE TRAFFIC.
- 2. EROSION CONTROLS SHALL BE IN PLACE PRIOR TO ANY SOIL DISTURBANCE, INCLUDING PAVEMENT REMOVAL.
- 3. ALL FOUNDATIONS, SLABS, STRUCTURAL STEEL, MASONRY, SIDEWALKS, RETAINING WALLS, CURB, APPARATUSES, PIPE, INLETS, VEGETATION, TREES, GRASS ETC., WITHIN THE DESIGNATED DEMOLITION LINES SHALL BE DEMOLISHED ACCORDING TO SPECIFICATIONS. ALL EXISTING UTILITIES, PAVEMENT, CURBS, FENCES, STRUCTURES OR OTHER IMPROVEMENTS MUST BE REMOVED WITHIN THE DEMOLITION AREA.
- 4. ALL CONCRETE SLABS, FOUNDATIONS, TREES, PIPES, FENCES, UTILITY POLES AND APPURTENANCES SHALL BE SPOILED OFF-SITE UNLESS OTHERWISE DIRECTED BY THE CITY'S REPRESENTATIVE. NO BURNING OF DEBRIS SHALL BE ALLOWED AND NO ON-SITE CONCRETE CRUSHING OPERATIONS OR ON-SITE DISPOSAL OF WILL BE ALLOWED.
- 5. THE CONTRACTOR SHALL BE PERMITTED TO SALVAGE ANY MATERIALS HE DEEMS FEASIBLE FOR THAT PURPOSE. ALL SALVAGED MATERIALS OR ITEMS SHALL BE REMOVED FROM THE SITE IMMEDIATELY UPON REMOVAL. NO SUCH MATERIAL SHALL BE STORED ON THE SITE AND ABSOLUTELY NO SALES OF SALVAGED MATERIALS WILL BE ALLOWED ON THE PROJECT SITE. ANY SALVAGED MATERIAL MUST BE REMOVED AND TRANSPORTED IN A LEGAL MANNER.
- 6. MANHOLES, CATCHBASINS, CLEANOUTS, VALVE BOXES, FRAMES, COVERS AND GRATES REMOVED SHALL REQUIRE THE AREA OF EXCAVATION BE ADJUSTED TO FINAL GRADE.
- 7. ABANDONMENT OF UTILITIES IN-PLACE SHALL BE ALLOWED.
- 8. ALL UTILITIES SHOWN TO BE REMOVED SHALL BE DISPOSED OF OFF SITE IN A LEGAL MANNER.
- 9. REMOVE EXISTING ELECTRICAL UTILITIES, IF ANY, ONLY AFTER CRITICAL NEW SYSTEMS ARE IN PLACE AND OPERATIONAL. IT IS THE CONTRACTOR'S RESPONSIBILITY TO PROVIDE PROPER REMOVAL INCLUDING SAFE SEQUENCING AND COORDINATION WITH APPROPRIATE UTILITY COMPANIES.
- 10. CONTRACTOR SHALL COORDINATE ALL DEMOLITION WORK WITH APPROPRIATE UTILITY COMPANIES PRIOR TO STARTING WORK.

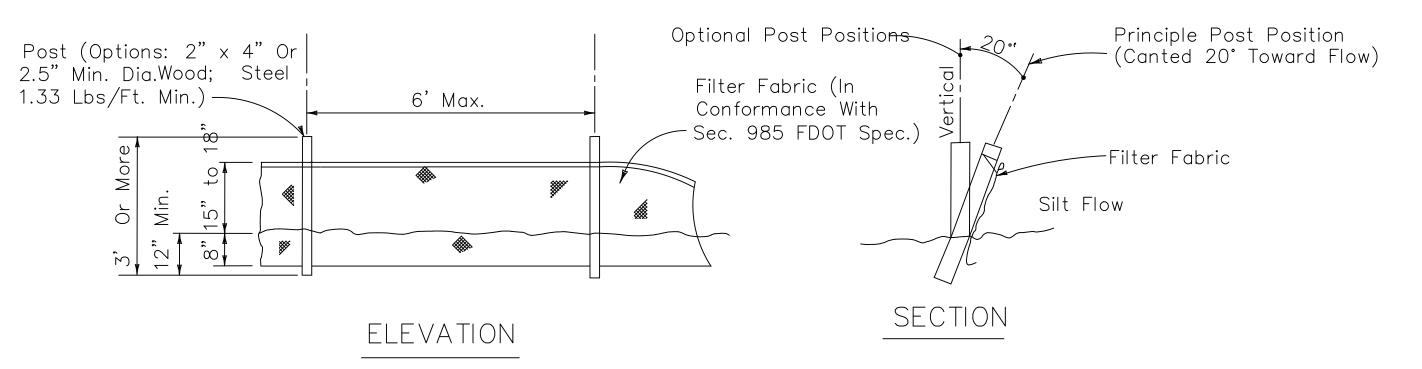

Note: Silt Fence to be paid for under the contract unit price for Staked Silt Fence (LF).

# SILT FENCE

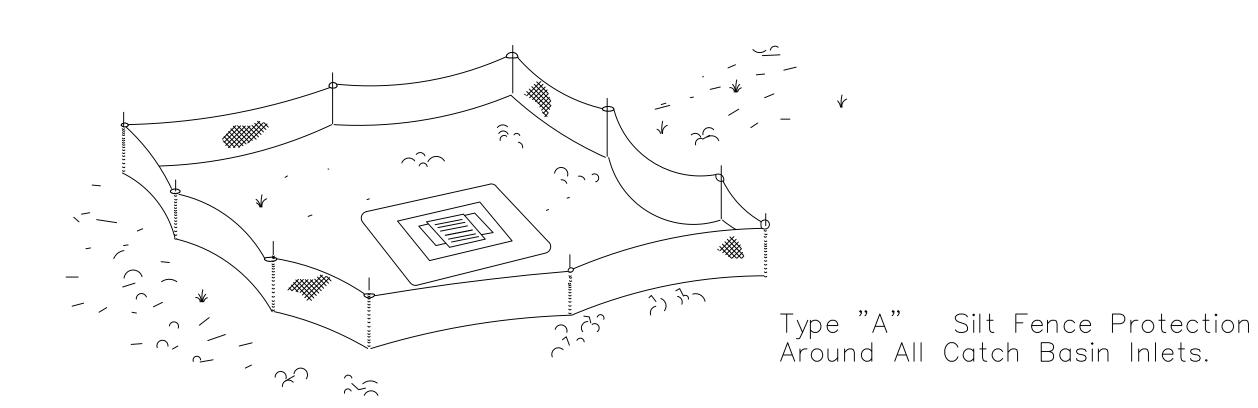

Do not deploy in a manner that silt fences will act as a dam across permanent flowing watercourses. Silt fences are to be used at upland locations and turbidity barriers used at permanent bodies of water.

## SILT FENCE APPLICATIONS

